




STILLING POND LAYOUT
Scale 1:250

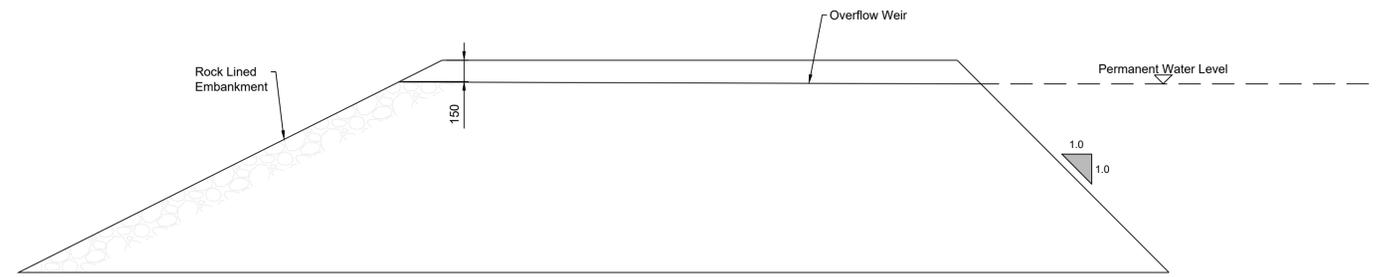

SECTION AT OUTLET
Scale 1:25

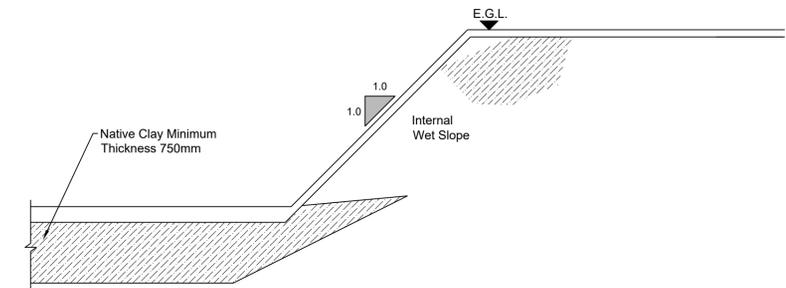

**BUND CONSTRUCTION
(Where Pond is Below Ground Level)**
Scale 1:25

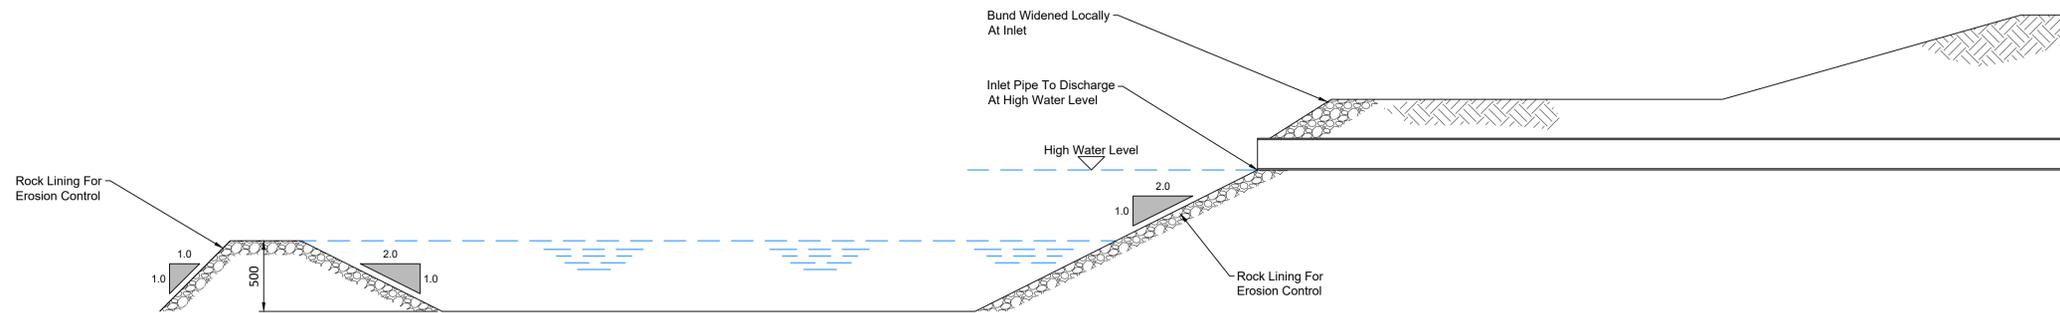

SECTION THROUGH FOREBAY
Scale 1:25

- NOTES**
1. This drawing should only be read in relation to subject of the title. Other information shown on drawing is to be considered indicative only.
 2. All dimensions are in millimetres unless otherwise stated.
 3. The pond base and sides below the permanent water level should be made impermeable by:
Cohesive material using native clay or a synthetic liner 1 mm LLDPE.
 4. Bunds in ponds to be constructed from native clay.
 5. Erosion control to be rock lining. Extent to be agreed on site.
 6. Rock lining to be a 125mm thickness of Class 1B material.
 7. Refer to stilling pond schedules for pond sizes.
 8. Swale inlet at 0.15 m below top of pond.
 9. All ponds to be fenced off.

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Rev.	Description	App By	Date
A	ISSUE FOR PLANNING	RM	10.10.23

PROJECT	CLIENT		
COUMNAGAPPUL WINDFARM EIAR	EMPOWER		
SETTLEMENT POND DETAILS - SHEET 1 OF 2	Date	10.10.23	Project number
	Drawn by	NS	P2360
	Checked by	RM	Drawing Number
		P2360-0501-0006	Scale (@ A1-) As Shown
			Rev A

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Monday 23 October 2023